
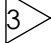
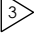


8 7 6 5 4 3 2 1

NOTES


- ELECTRICAL INSTALLATION MUST BE COMPLETED BY A QUALIFIED ELECTRICIAN IN ACCORDANCE WITH ALL APPLICABLE CODES AND REGULATIONS
- CONFIRM THAT THE MAINS VOLTAGE CONFORMS TO REQUIREMENTS BEFORE CONNECTING THE MACHINE OR ACCESSORIES
-  NOMINAL VOLTAGE. VOLTAGES AS LOW AS 208V ARE PERMISSIBLE BUT WILL REDUCE SPINDLE PERFORMANCE.

ITEM NO.	DEVICE	VOLTAGE	RUNNING WATTAGE	PEAK WATTAGE	BREAKER	CONNECTOR
1	BASE MACHINE • MILL • CONTROLLER • FLOOD COOLANT • MIST COOLANT • WASHDOWN COOLANT • AUTOMATIC TOOL CHANGER (OPTION)	240V (1Ø) 	4.4kW	6.0kW	30A	NEMA L6-30P
2	THROUGH SPINDLE COOLANT PUMP (OPTION)	240V (1Ø)	2.6kW	4.3kW	20A	NEMA 6-20P
3	CHIP CONVEYOR (OPTION)	240V (1Ø)	0.25kW	0.25kW	5A	NEMA 6-20P
4	MIST COLLECTOR (OPTION)	240V (1Ø)	0.5kW	1.5kW	10A	NEMA 6-20P
5	OIL SKIMMER (OPTION)	120V (1Ø)	0.2kW	0.2kW	15A	NEMA 5-15P

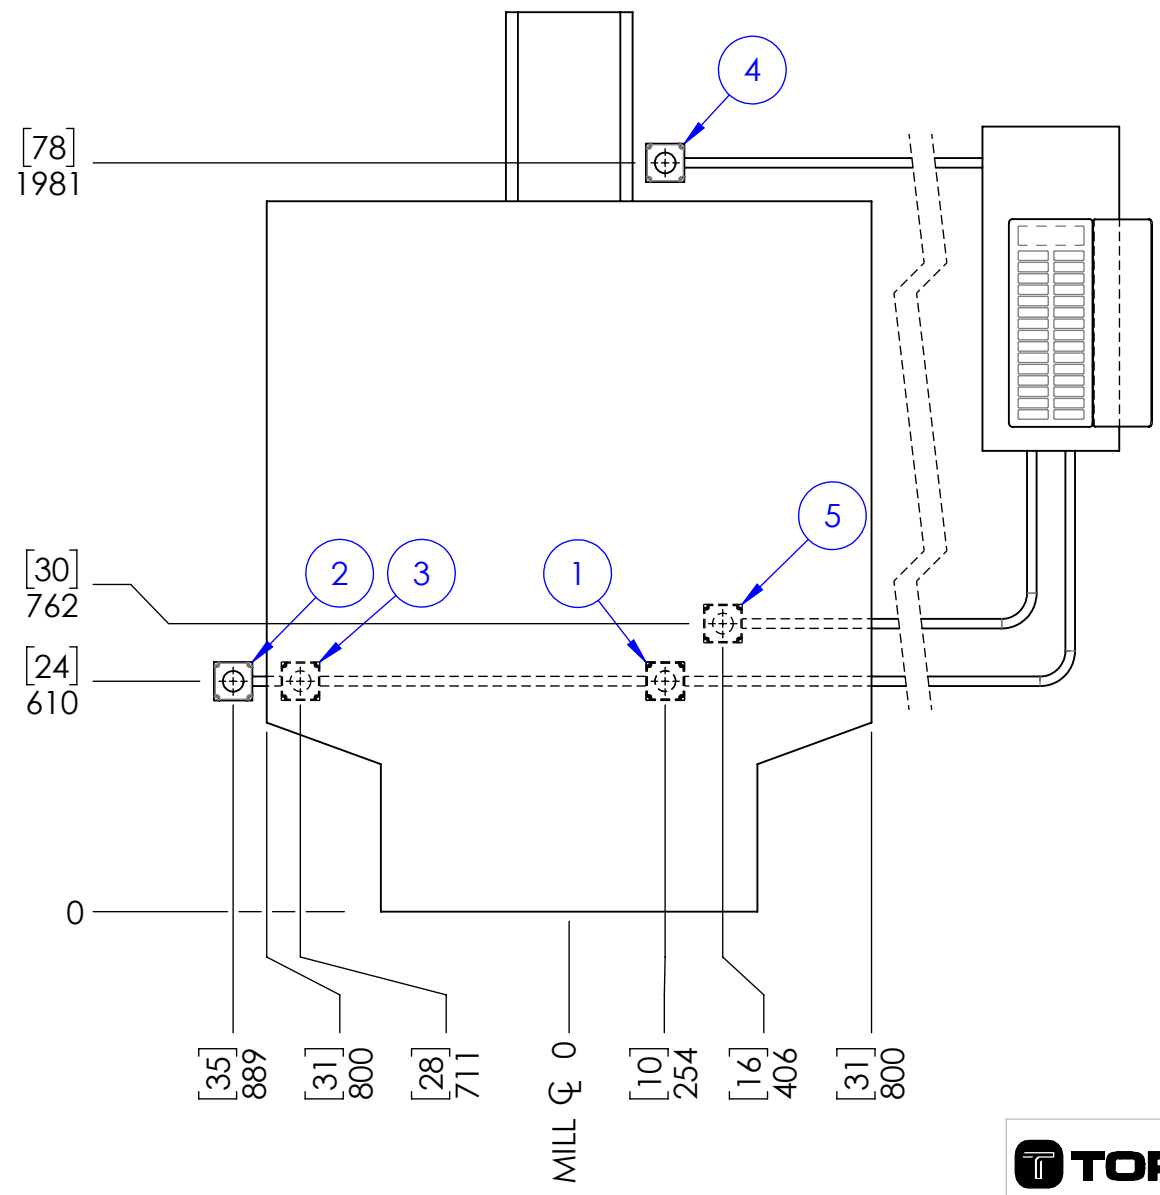

4009 FELLAND ROAD, STE. 120
MADISON, WI 53716
(608) 849-8381

THIS DRAWING CONTAINS PROPRIETARY AND CONFIDENTIAL INFORMATION BELONGING TO TORMACH INC. THIS DRAWING MAY NOT BE REPRODUCED OR COPIED IN WHOLE OR IN PART NOR CAN THE INFORMATION CONTAINED BE USED FOR ANY PURPOSE WITHOUT THE EXPRESS WRITTEN PERMISSION OF TORMACH INC

	DRAWN BY	DATE
	MCB	2024-02

TITLE:
ELECTRICAL SITE PLAN, 1500MX

MATERIAL
DO NOT SCALE DRAWING

SIZE	DWG. NO.	REV
B	53096	A

SCALE: 1:20 SHEET 1 OF 1

REV.	DESCRIPTION	DATE
A	INITIAL RELEASE	2024-03
REVISIONS		

8 7 6 5 4 3 2 1